

## GENERAL NOTES

This drawing is not to be scaled, all figured dimensions to be used.

All dimensions and cadastral setting out information to be thoroughly checked on site and all or any discrepancies to be reported to the Architect before any work is put in hand.

All work is to comply with the NATIONAL BUILDING REGULATIONS (NBR) AND BUILDING STANDARDS act 103 of 1977 as amended.

All work is to comply with all relevant specifications and codes of practice of the SOUTH AFRICAN BUREAU OF STANDARDS (SABS) / SOUTH AFRICAN NATIONAL STANDARDS (SANS) and amendments thereto.

HEALTH AND SAFETY: All construction activities to conform to the OCCUPATIONAL HEALTH AND SAFETY ACT 1993 (Act No 85 of 1993)

All materials and workmanship to be as per the MODEL PREAMBLES FOR TRADES 2008, and any further additional preambles as noted in the Bills of Quantities.

All work is to comply with all relevant specifications and codes of practice of the NATIONAL HOME BUILDERS REGISTRATION COUNCIL (NHBC) (Where applicable)

ELECTRICAL Engineer: (Where applicable) All materials and workmanship to be as specified on the Consultants drawings.

STRUCTURAL and CIVIL Engineer: (Where applicable) All materials and workmanship to be as specified on the Consultants drawings.

HVAC Engineer: (Where applicable) All materials and workmanship to be as specified on the Consultants drawings.

RATIONAL FIRE Engineer: (Where applicable) All materials and workmanship to be as specified on the Consultants drawings.

WET SERVICES Engineer: (Where applicable) All materials and workmanship to be as specified on the Consultants drawings.

SPECIALIST CONSULTANTS (Where applicable) All materials and workmanship to be as specified on the Consultants drawing.

A ISSUED FOR INFORMATION 19-07-2022  
REV: DESCRIPTION: DATE:

## PROPORTION DESIGN

CLIENT: [REDACTED]

PROJECT: NANDOS ELDORADO PARK

ERF NO: [REDACTED]


AFRI MODERN - STORYTELLING THROUGH DESIGN  
SIFISO SHANGE - 074 853 6944 - info@sifisoshange.co.za

## NOBUHLE CONDIMENT UNIT DETAILS LAYOUT

FURNITURE As indicated 19-07-2022  
DISCIPLINE: SCALE: DATE:


SS DRAWN: SS SS CHECK: SS

PROJECT: NE-22 DWG NO: SF-003 REV: A

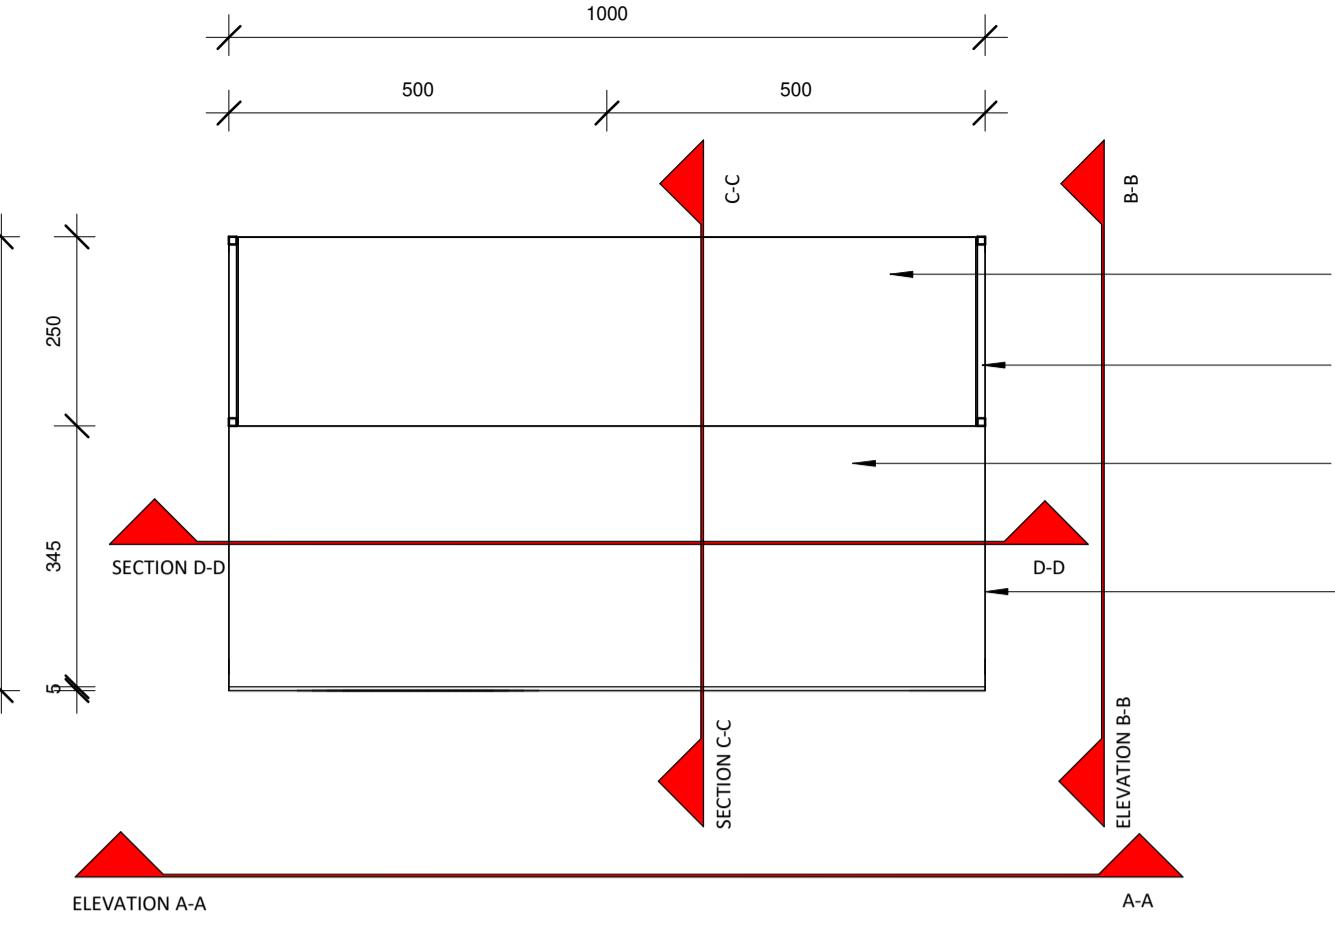


PLAN OF NOBUHLE CONDIMENT UNIT

SCALE 1:10

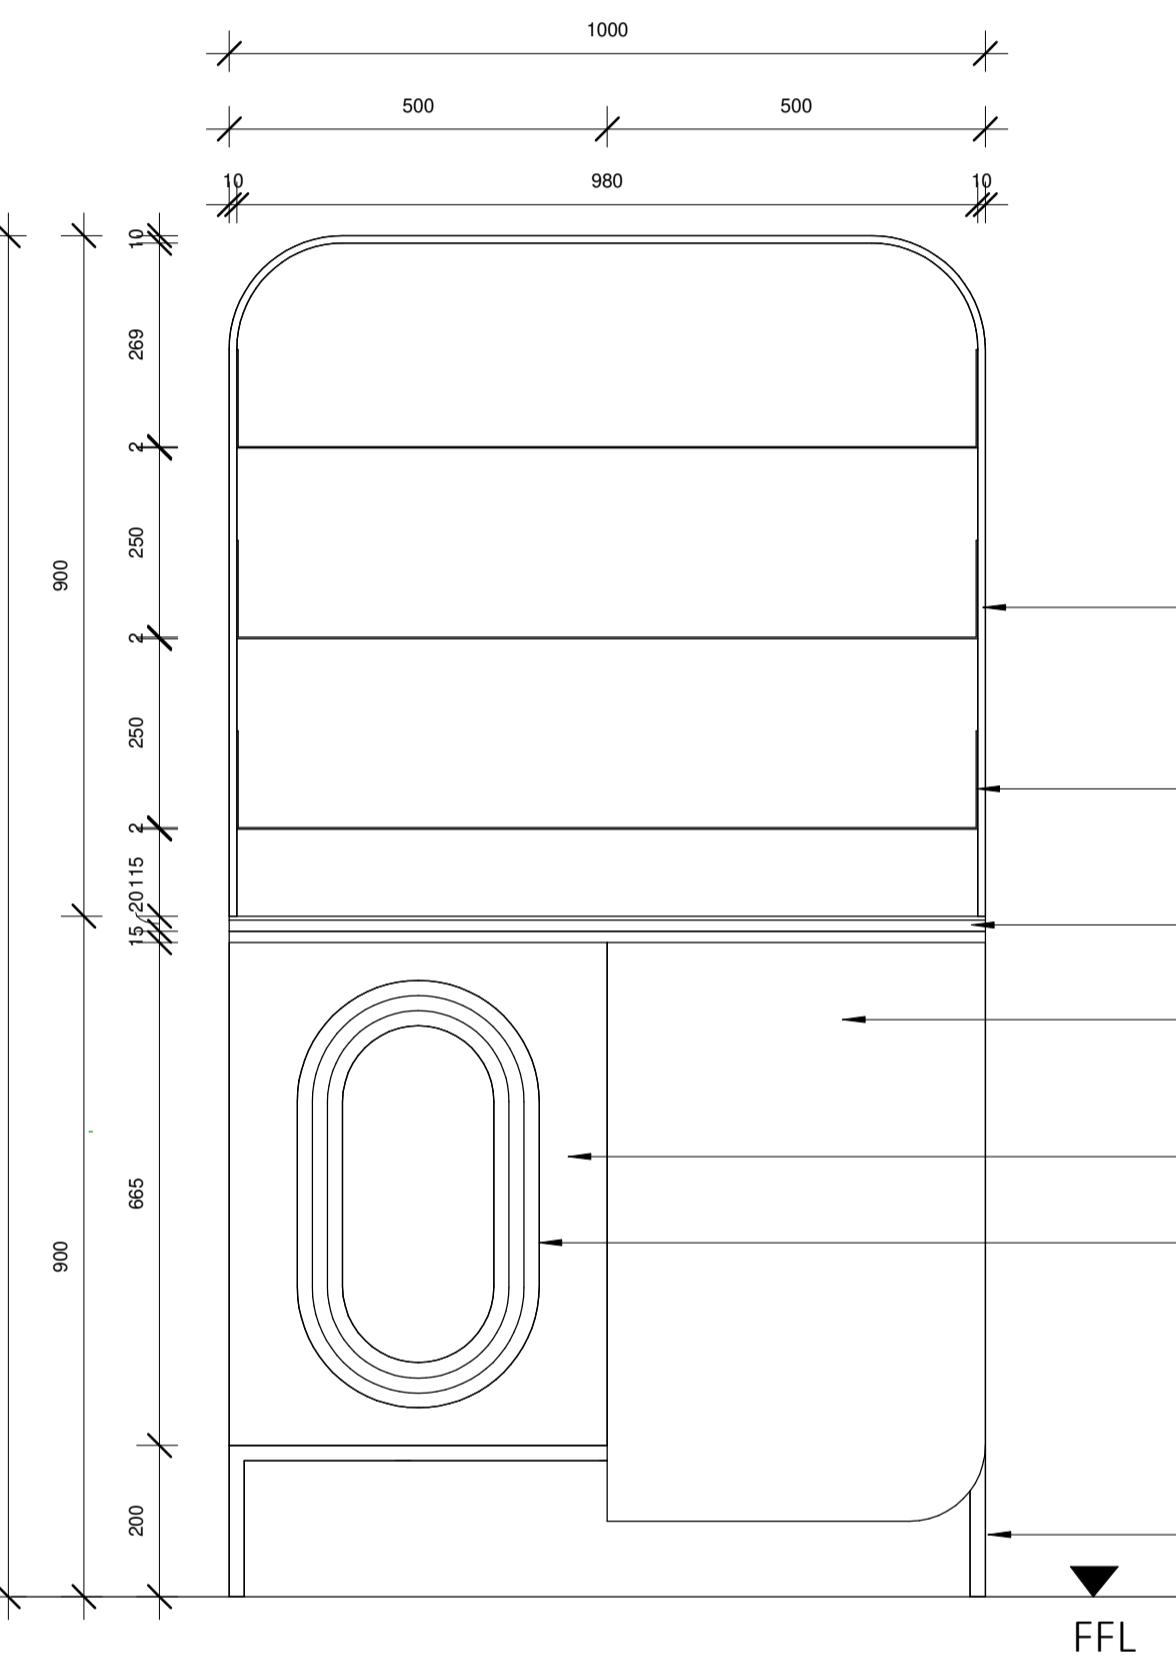


FRONT ELEVATION A-A OF NOBUHLE CONDIMENT UNIT

SCALE 1:10

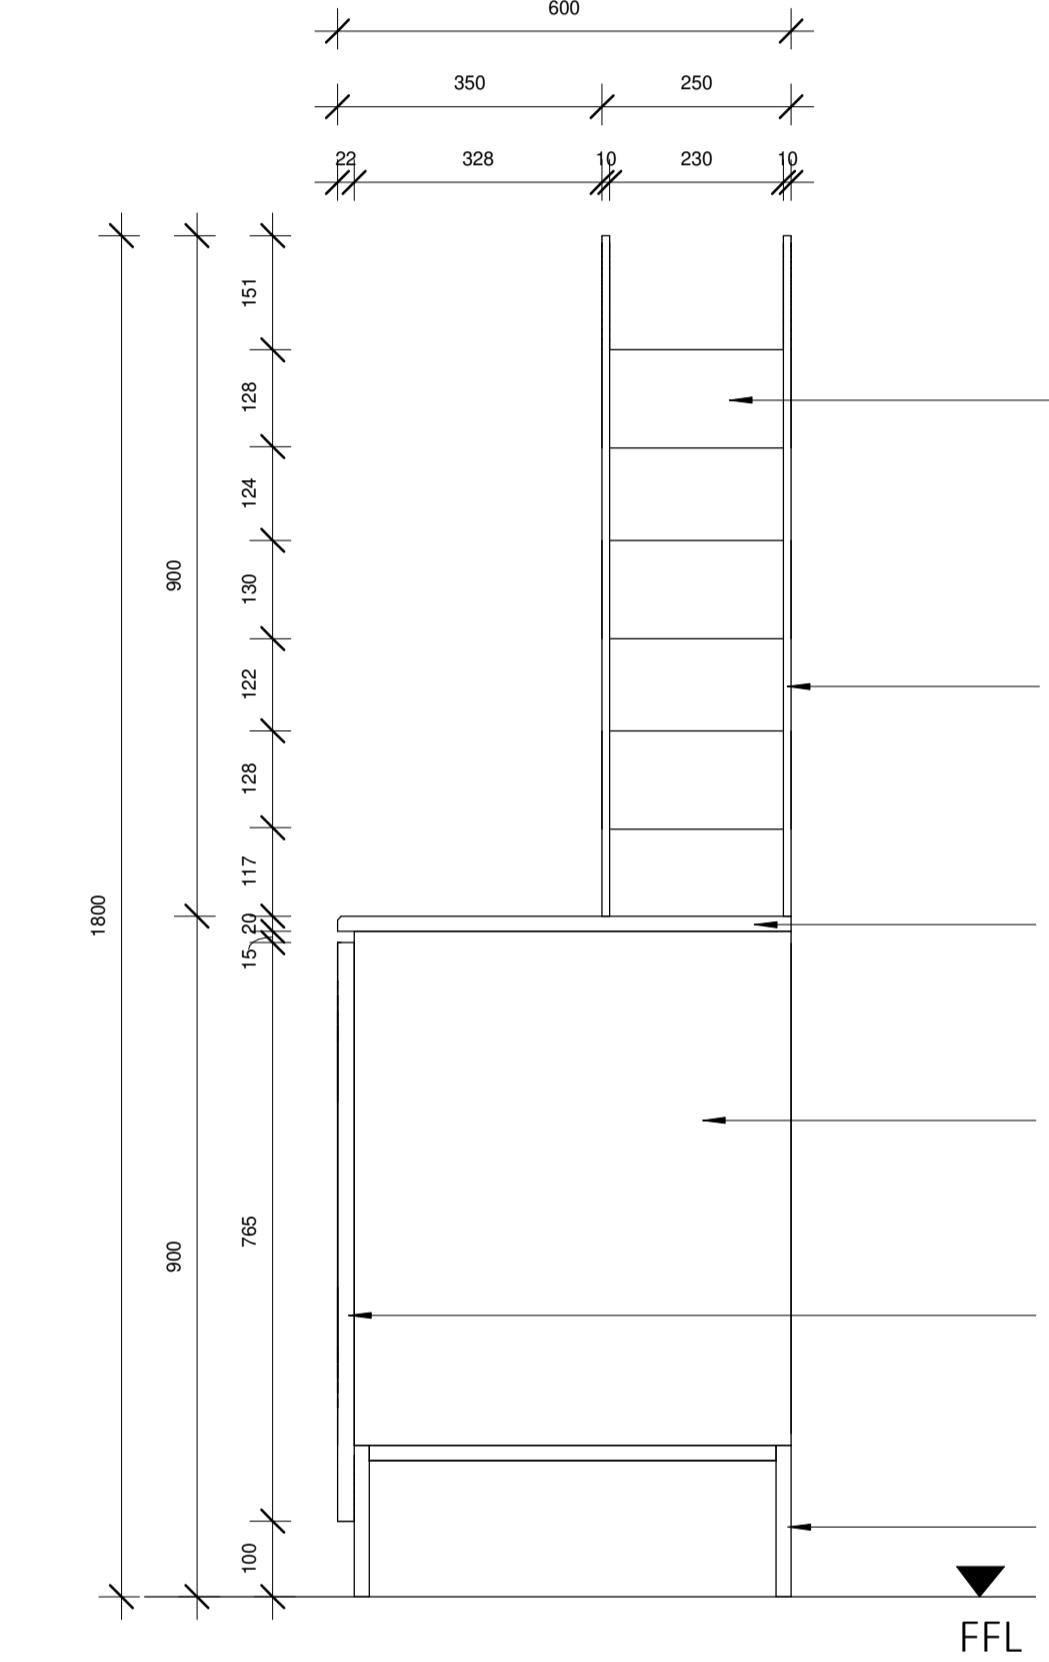


SIDE ELEVATION B-B OF NOBUHLE CONDIMENT UNIT

SCALE 1:10

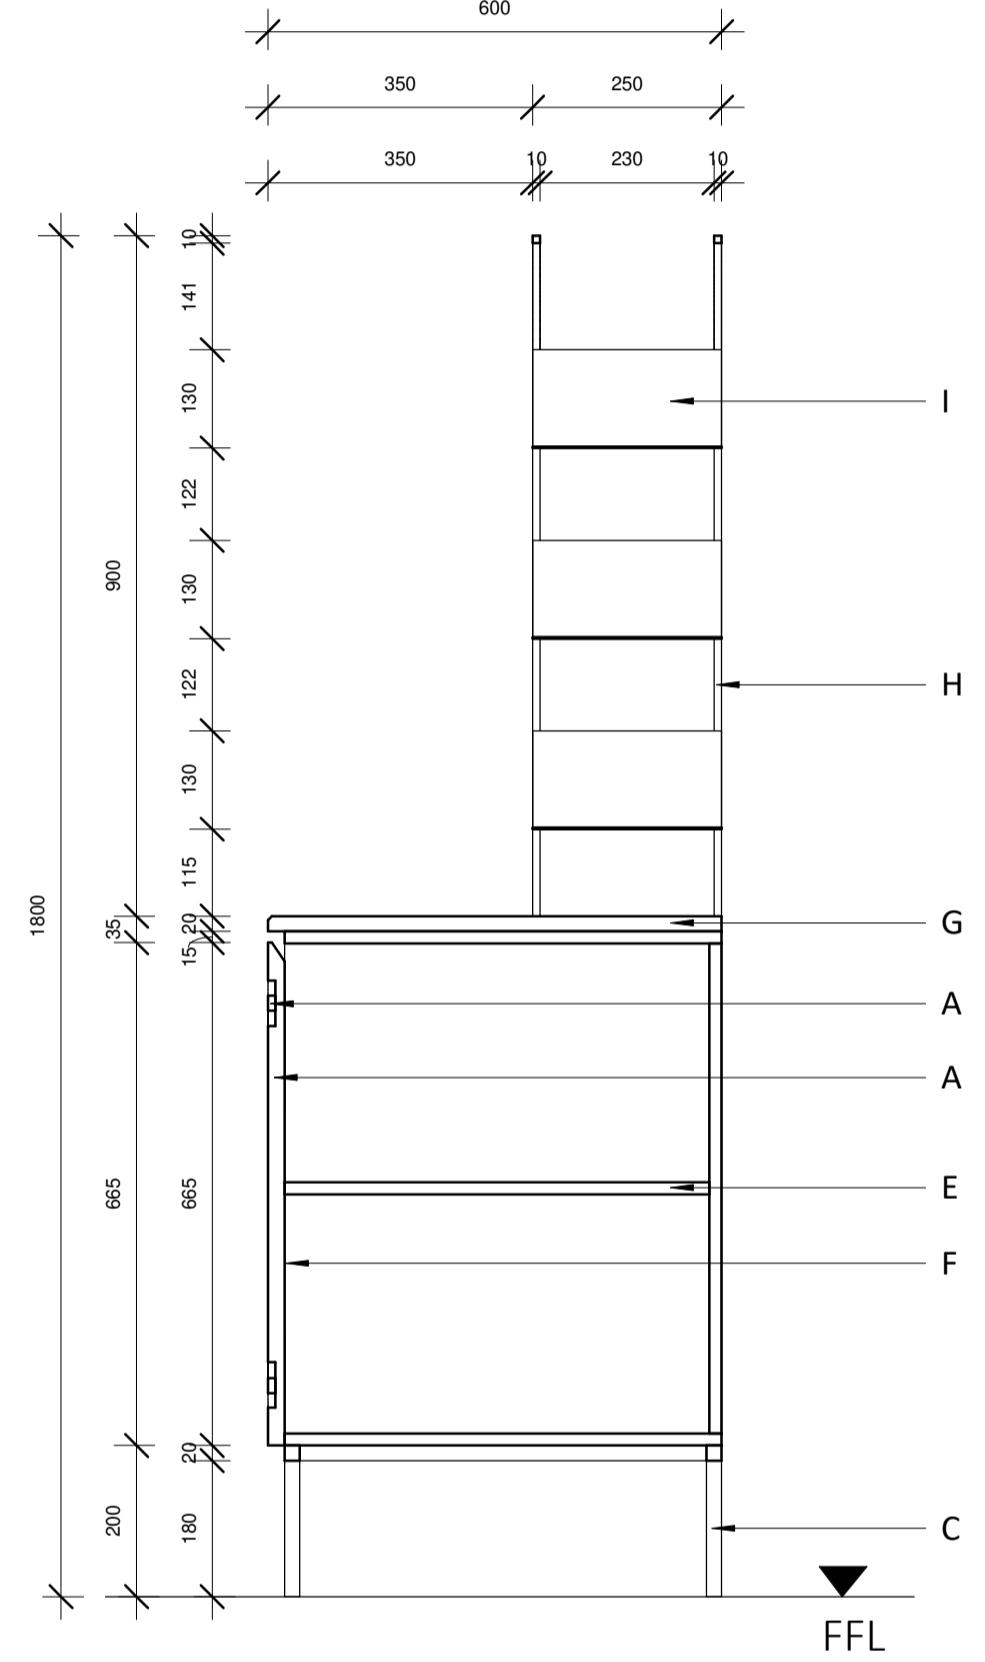


SIDE SECTION C-C OF NOBUHLE CONDIMENT UNIT

SCALE 1:10

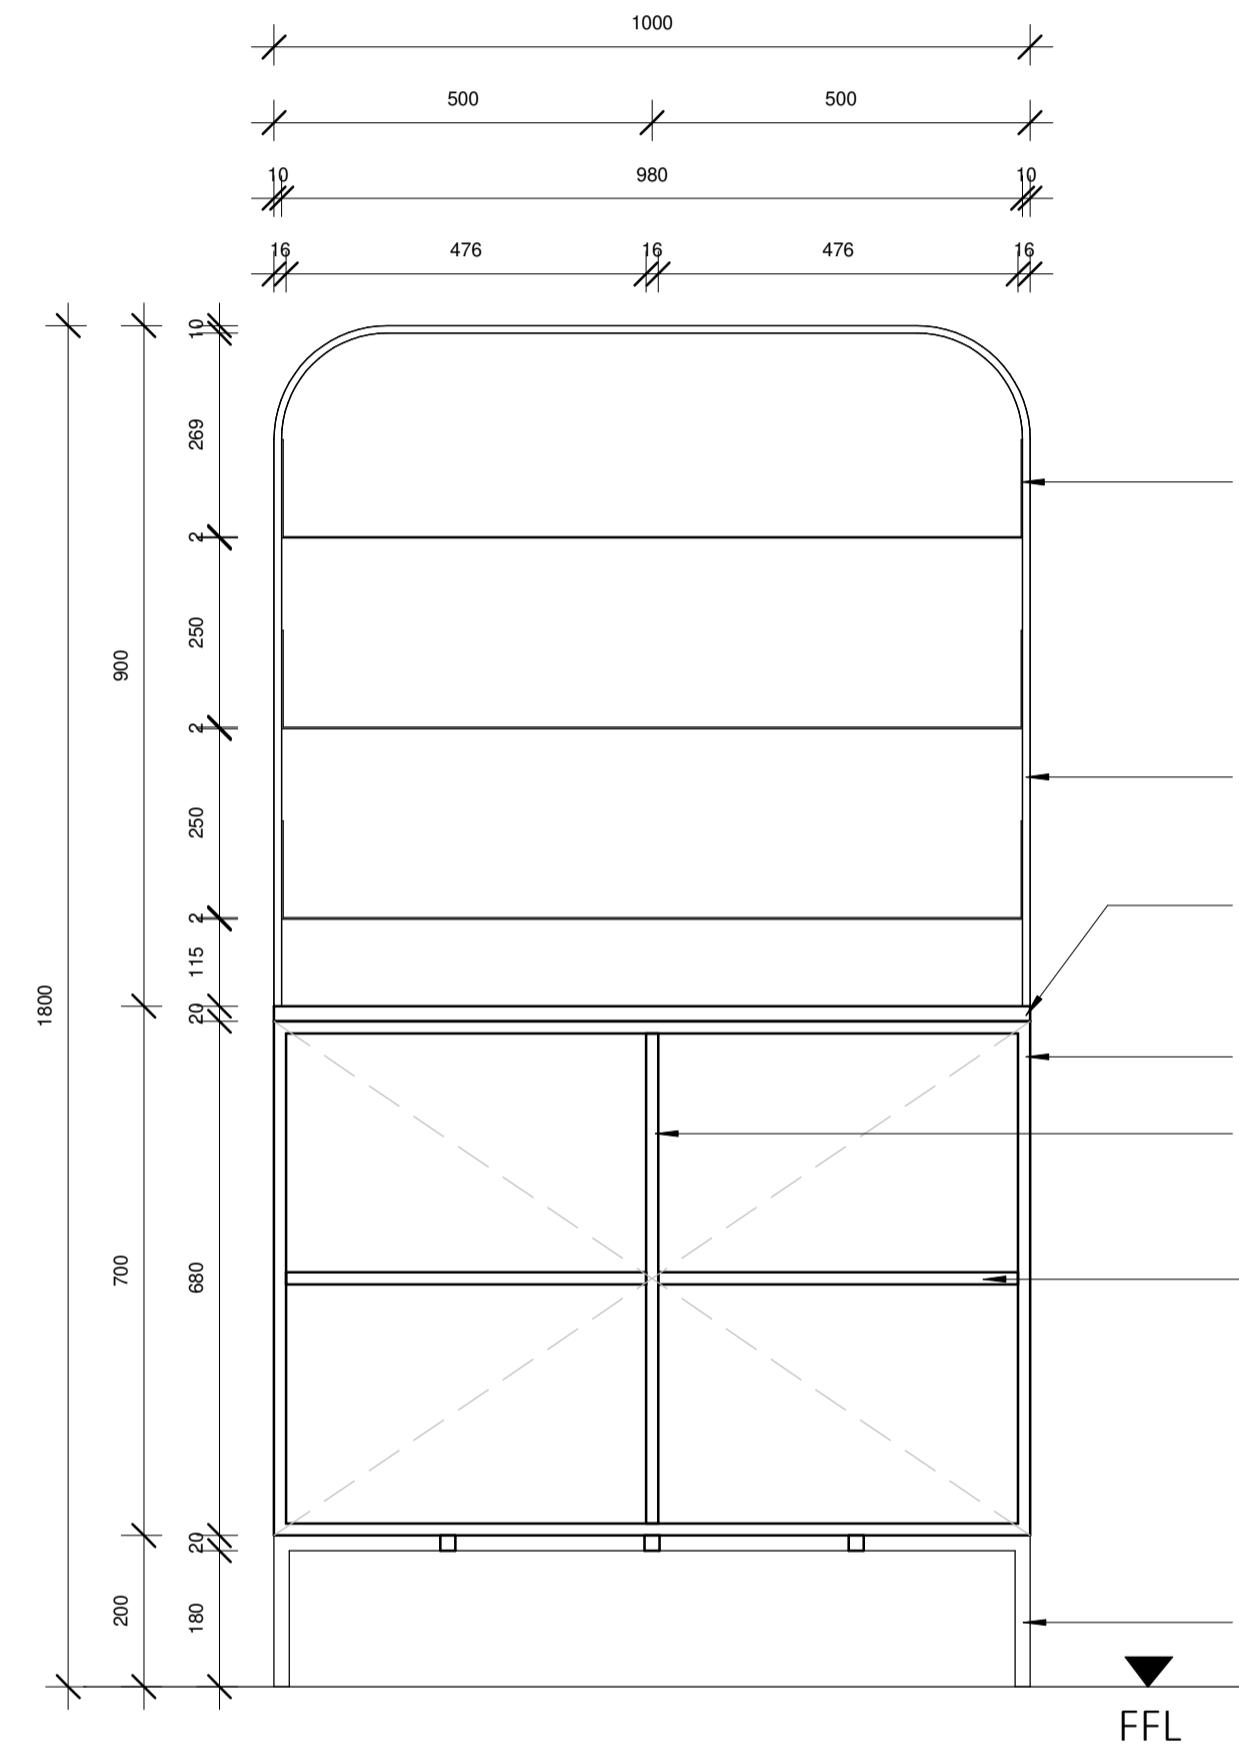

SIDE SECTION D-D OF NOBUHLE CONDIMENT UNIT

SCALE 1:10

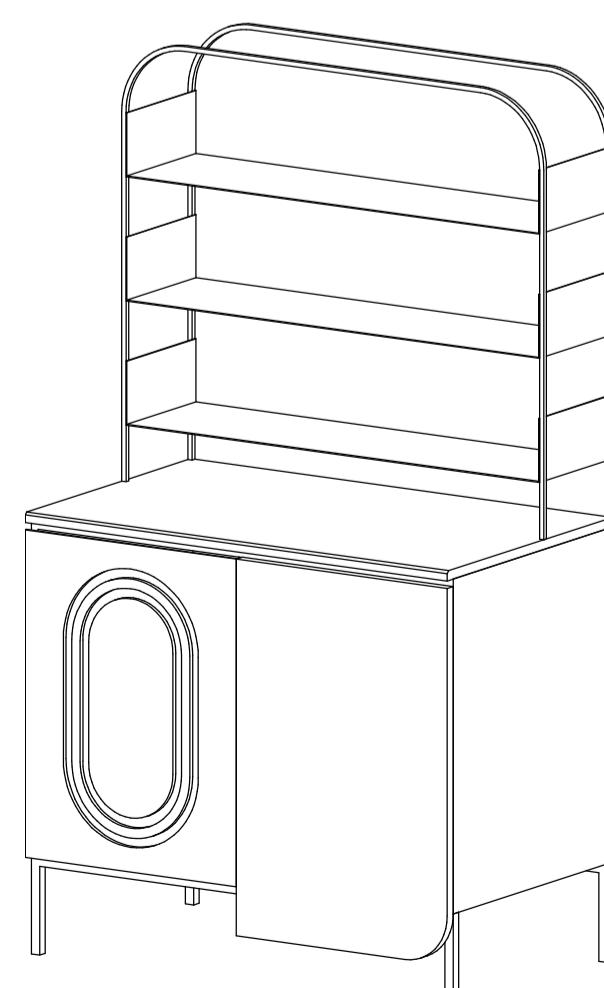

NOTE:  
ALL FINISHES & DETAILED SPECIFICATIONS TO BE  
DISCUSSED WITH THE DESIGNER & CLIENT PRIOR TO  
FINAL MANUFACTURE OF THE ITEM

MATERIAL LEGEND				
LETTER	THICKNESS/ DIMENSIONS	DESCRIPTION	MATERIAL	COLOUR/CODE
A	22mm	FINGER GRIP DOOR BLUM SOFT CLOSE HINGES	MDF IN POLYURETHANE DUKO SATIN FINISH	COLOUR BY DESIGNER
B	15mm	AFRI MODERN PATTERN CNC - 5mm GROOVE OUT WITH 3mm MDF INLAY INTO GROOVE OUT	MDF IN POLYURETHANE DUKO SATIN FINISH	COLOUR BY DESIGNER
C	20mm	BASE FRAME	POWDER COATED MILDSTEEL FRAME IN MATT FINISH	COLOUR BY DESIGNER
D	16mm	CABINET CARCASS	MDF IN POLYURETHANE DUKO SATIN FINISH	COLOUR BY DESIGNER
E	16mm	SERVER SHELF	MDF IN POLYURETHANE DUKO SATIN FINISH	COLOUR BY DESIGNER
F	16mm	SERVER DIVIDER	MDF IN POLYURETHANE DUKO SATIN FINISH	COLOUR BY DESIGNER
G	20mm	CONDIMENT WORKTOP	STONE	COLOUR BY DESIGNER
H	10mm	TOP SHELF FRAME	POWDER COATED MILDSTEEL FRAME IN MATT FINISH	COLOUR BY DESIGNER
I	2mm	SHELVES	POWDER COATED MILDSTEEL FRAME IN MATT FINISH	COLOUR BY DESIGNER